

ACCESS ROAD DETAIL 21

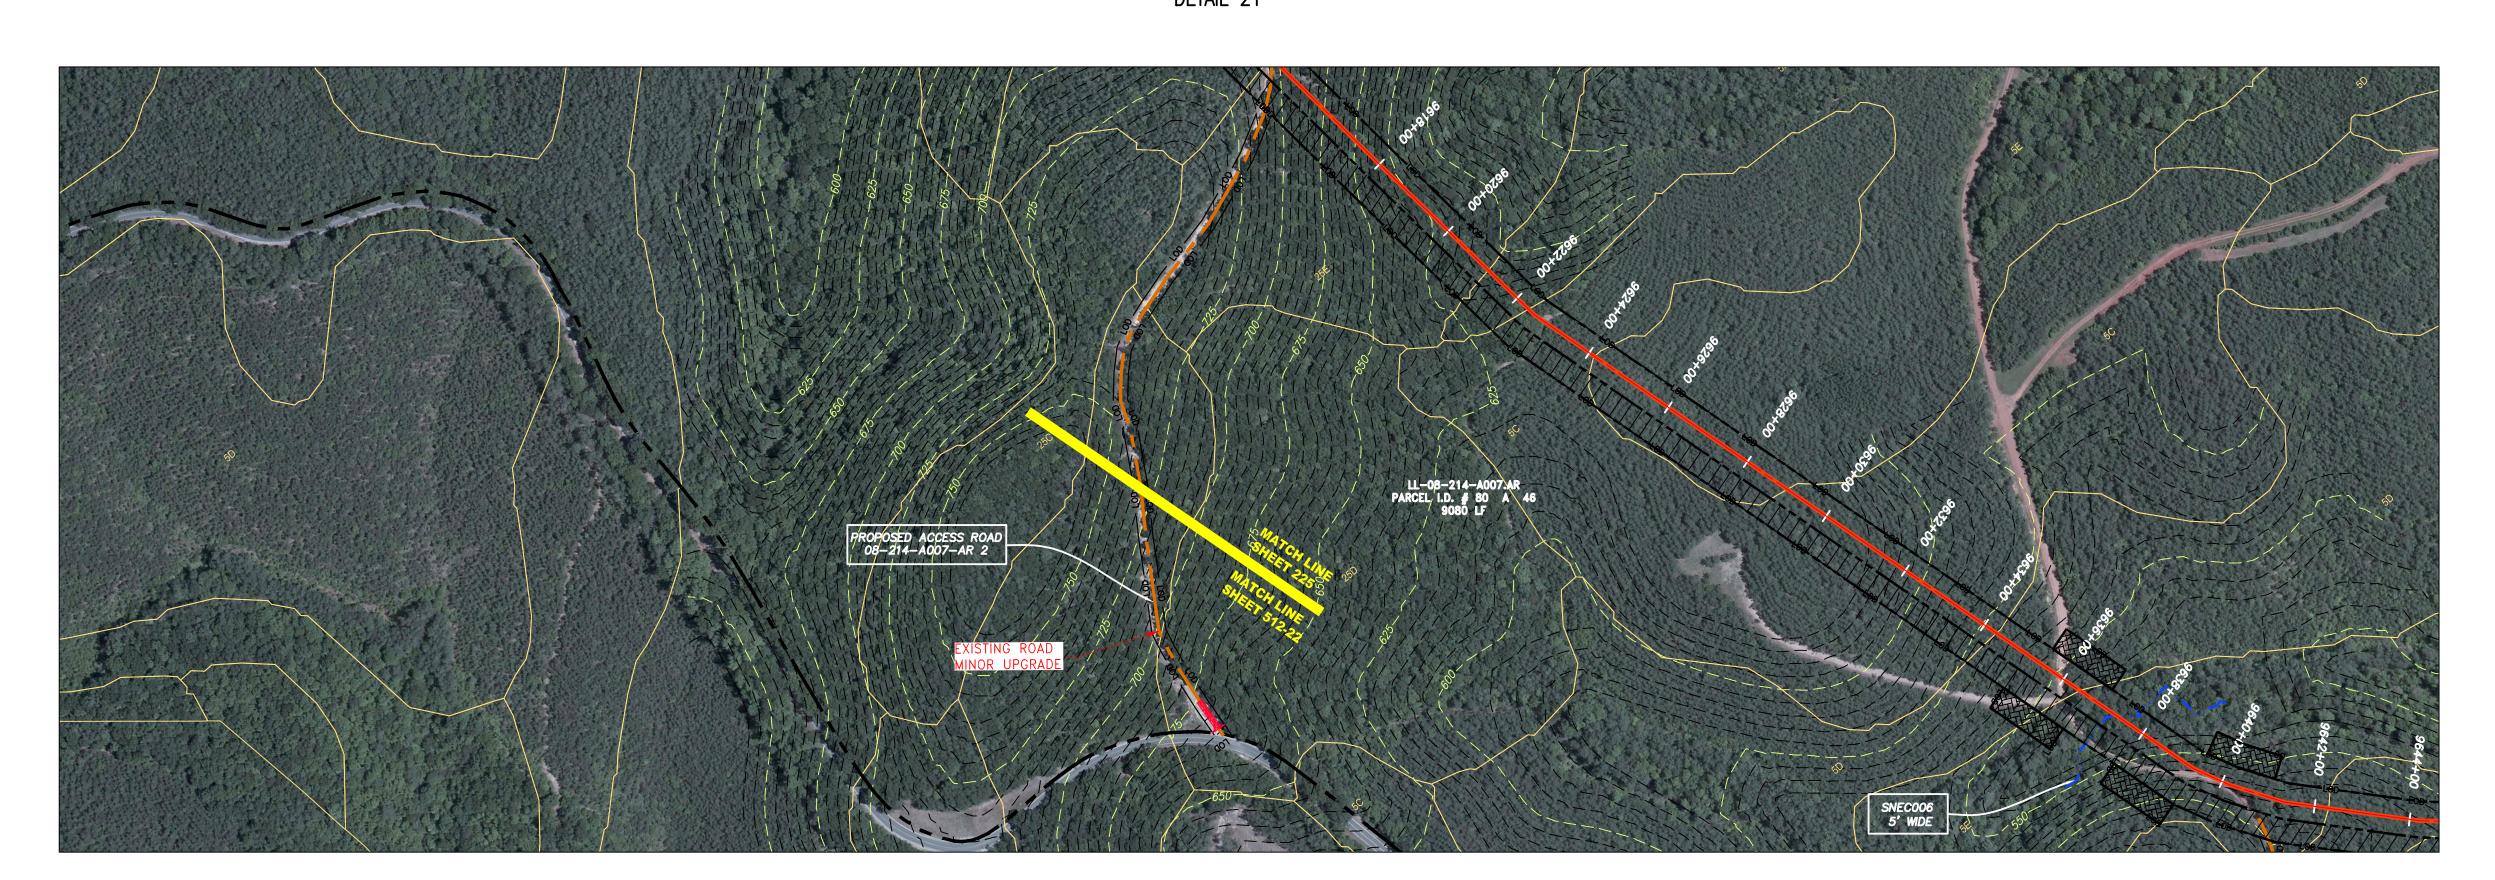

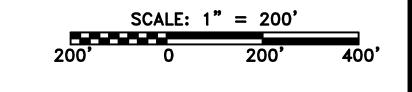

_ _ _ _ _ _ _ _ STORM SEWER **EXTRA WORK SPACE** TOPSOIL SEGREGATION AREA _____ UNDERGROUND ELECTRIC AREA OF NO DISTURBANCE -G - SAN- SANITARY SEWER UTILITY POLE ____ OVERHEAD UTILITY LINES . **ACCESS ROAD** PROPOSED PERMANENT EASEMENT NOTE: THE PE SEAL AND SIGNATURE APPLIES ONLY TO THE E&S CONTROL DESIGN COMPLETED BY ERM (SEE NOTE 12). PROPOSED GAS PIPELINE PROPOSED GAS PIPELINE (NO GROUND SURVEY)

TEMPORARY WATERBAR/SLOPE BREAKER TRENCH BREAKER/PLUG STREAM CROSSING PROPOSED TEMPORARY R.O.W. **USFWS STREAM CROSSING** WITH ENHANCED CONTROLS SLOPE DIRECTION CONSTRUCTION ENTRANCE WITH DITCH CULVERT AS NEEDED CULVERT/ WATERBAR

PERMANENT WATERBAR/SLOPE BREAKER ——— LOD ——— LIMIT OF DISTURBANCE 30-58% SLOPE INCLINATION

BELTED SILT RETENTION FENCE (BSRF) COMPOST FILTER SOCK 111.03 SEDIMENT BARRIER IDENTIFICATION C 111.001 CULVERT IDENTIFICATION ORANGE SAFETY FENCE ROADSIDE DITCH SOIL TYPE A1 (E) TYPICAL BIC SLOPE CATEGORY

NOTES:1. COORDINATE SYSTEM USED FOR MAPPING AND TOPOGRAPHY - UTM WITH NAD83 DATUM, ZONE 17, US SURVEY FOOT, CENTRAL MERIDIAN 81° W. CONTOURS AND TOPOGRAPHIC FEATURES WERE DERIVED FROM LIDAR DATA AND GPS SUB-METER GROUND SURVEY PERFORMED BY GAI CONSULTANTS, INC FROM 11-03-2014 THRU 11-07-2014. 11-07-2014.

3. IMAGERY TAKEN FROM GOOGLE EARTH.

4. THE PROPERTY LINES SHOWN ARE BASED ON GIS & TAX ASSESSMENT RECORDS (PROVIDED BY OTHERS). GAI CONSULTANTS MAKE NO GUARANTEE EITHER EXPRESSED OR IMPLIED AS TO THE ACCURACY OF THE RECORDS AS SHOWN ON THESE DRAWINGS.

5. STREAM AND WETLAND DATA SHOWN ON THE DRAWINGS WAS PROVIDED BY ERM.

6. EROSION AND SEDIMENTATION CONTROL ELEMENTS MAY BE SHOWN OUTSIDE OF THE WORK AREAS FOR CLARITY ONLY. ACTUAL INSTALLATION SHALL BE WITHIN THE WORK AREAS.

7. ALL STATIONING SHOWN IS SLOPE STATIONING.

8. SILT FENCE AND FILTER SOCK SHALL BE INSTALLED PARALLEL TO CONTOUR TO EXTENT PRACTICABLE IN ACCORDANCE WITH STANDARD DETAIL

9. BEST IN CLASS (BIC) STEEP SLOPE CATEGORY INFORMATION CAN BE FOUND IN THE APPENDIX OF THE STORMWATER POLLUTION PREVENTION PLAN.

10. EROSION CONTROL MATTING SHALL BE PLACED IN AREAS OF 30% SLOPE AND GREATER, WHICH ARE INDICATED ON THE BEST IN CLASS STEEP SLOPES BAND.

11. ACCESS ROADS HAVE BEEN GROUPED INTO FOUR CATEGORIES - 1) EXISTING ROADS NO IMPROVEMENTS, 2) EXISTING ROADS MINOR IMPROVEMENTS, 3) EXISTING ROADS MAJOR IMPROVEMENTS AND 4) NEW ROADS. APPROPRIATE EROSION AND SEDIMENT CONTROLS WILL BE PROVIDED FOR ROADS IN CATEGORIES 2, 3 AND 4. ROADS IN CATEGORIES 1 AND 2 HAVE ADEQUATE EXISTING DRAINAGE; DRAINAGE; BEATURES WILL BE PROVIDED FOR ROADS IN CATEGORIES 3 AND 4.

12. *ERM IS SOLELY RESPONSIBLE FOR THE NATURE AND LOCATION OF THE DEPICTED BMPS AS OF THE DATE SIGNED AND SEALED BASED ON THE SOURCE DATA PROVIDED AND AS DESCRIBED IN THE NOTES SECTION OF THE INDEX SHEET OF THIS PLAN SET.

DESCRIBED IN THE NOTES SECTION OF THE INDEX SHEET OF THIS PLAN SET.

13. THE CONSTRUCTION RIGHT-OF-WAY (ROW) WILL BE RESTORED TO PRE-CONSTRUCTION CONTOURS IN ACCORDANCE WITH SECTION V.A.5 FEDERAL ENERGY REGULATORY COMMISSION (FERC) UPLAND EROSION CONTROL, REVEGETATION, AND MAINTENANCE PLAN, SECTION V.A.5. IN ADDITION, WETLAND AND WATERBODY CROSSINGS WILL BE RESTORED TO PRE-CONSTRUCTION CONTOURS IN ACCORDANCE WITH NATIONWIDE PERMIT 12 (NWP) ISSUED BY THE U.S. CORPS OF ENGINEERS.

THIS DRAWING WAS PRODUCED WITH COMPUTER AIDED DRAFTING TECHNOLOGY AND IS SUPPORTED BY ELECTRONIC DRAWING FILES. DO NOT REVISE THIS DRAWING VIA MANUAL DRAFTING METHODS.

DANIEL R. GOLDSTEIN ERM

SCALE: AS SHOWN 6/20/17 DRAWN: **GPT** CHECKED: **DLH** APPROVED: **NET**


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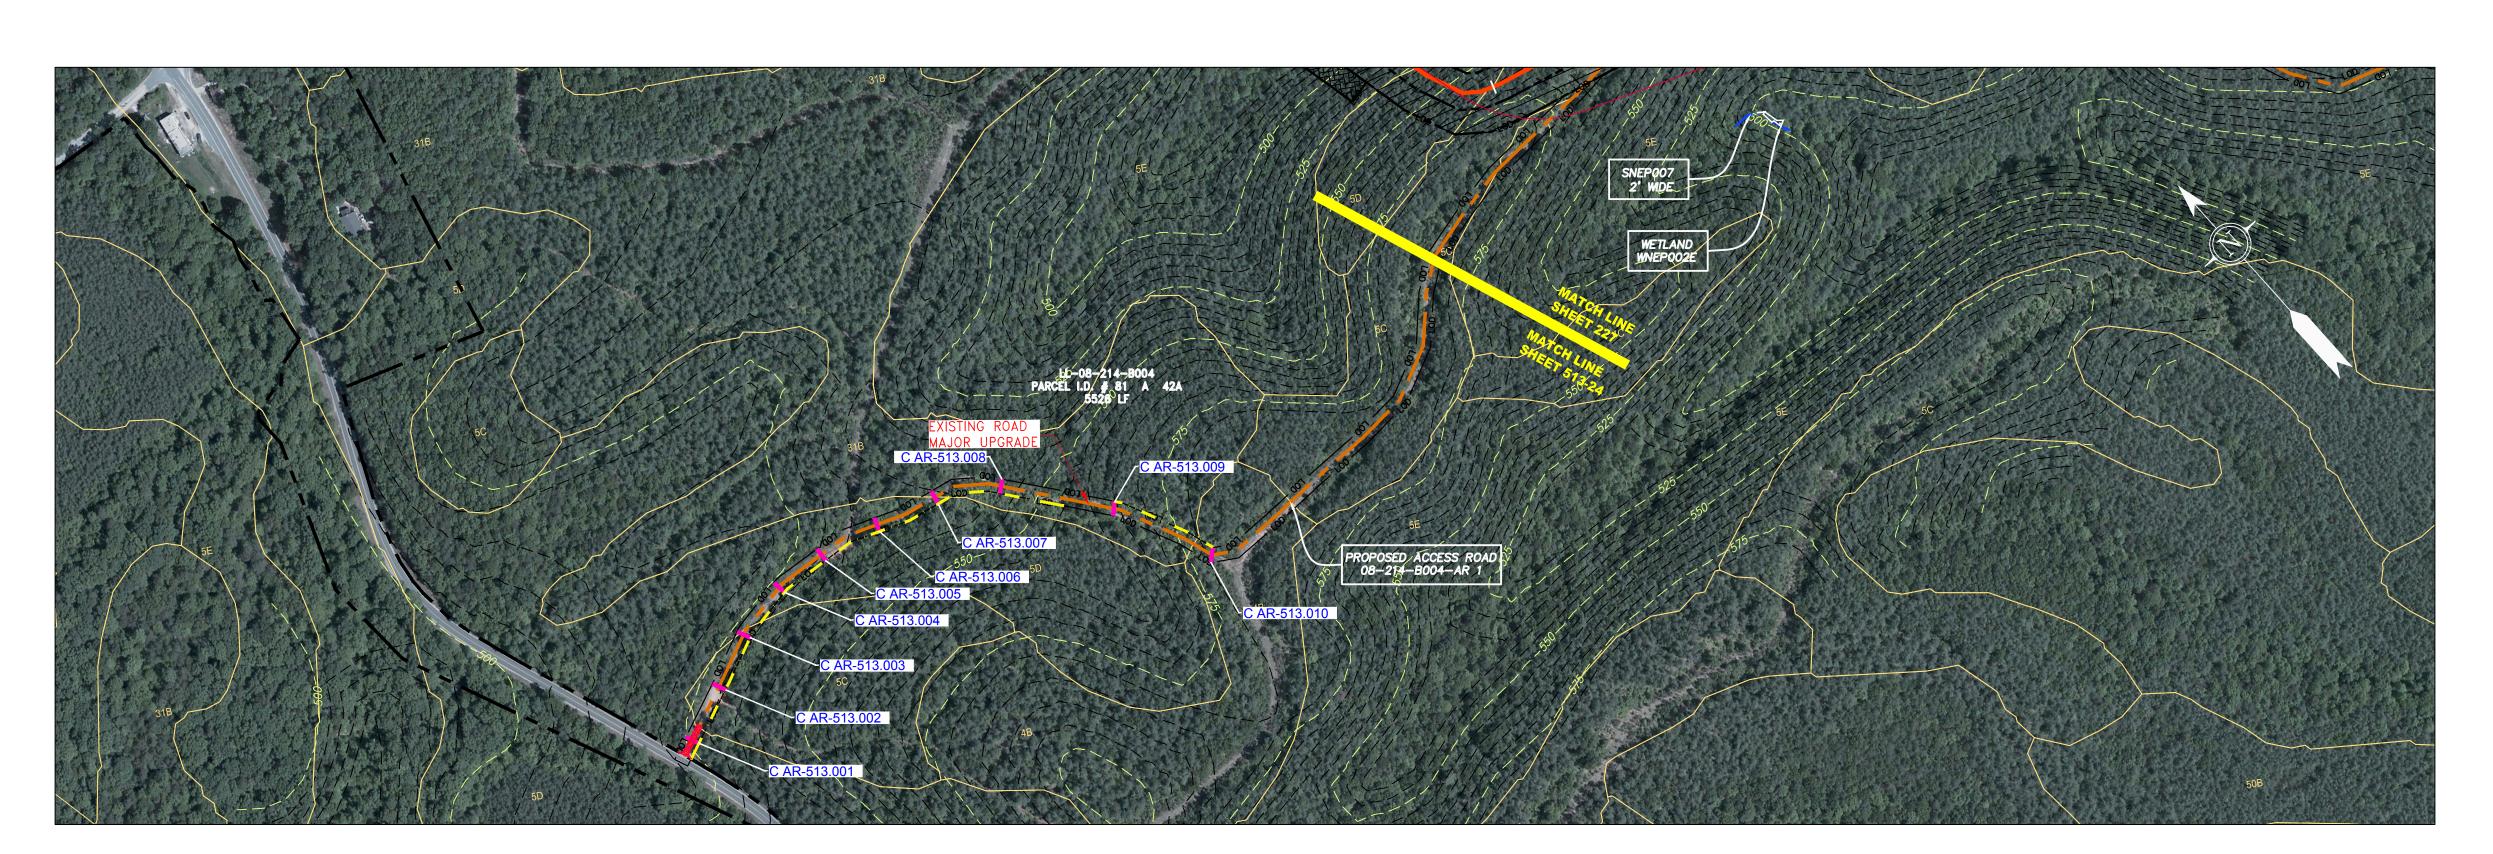
PROJECT NO./DASH NO 140468 00


TASK NO. SUB TASK NO GROUP ID DRAWING NO. E512

AR-512



ACCESS ROAD DETAIL 23

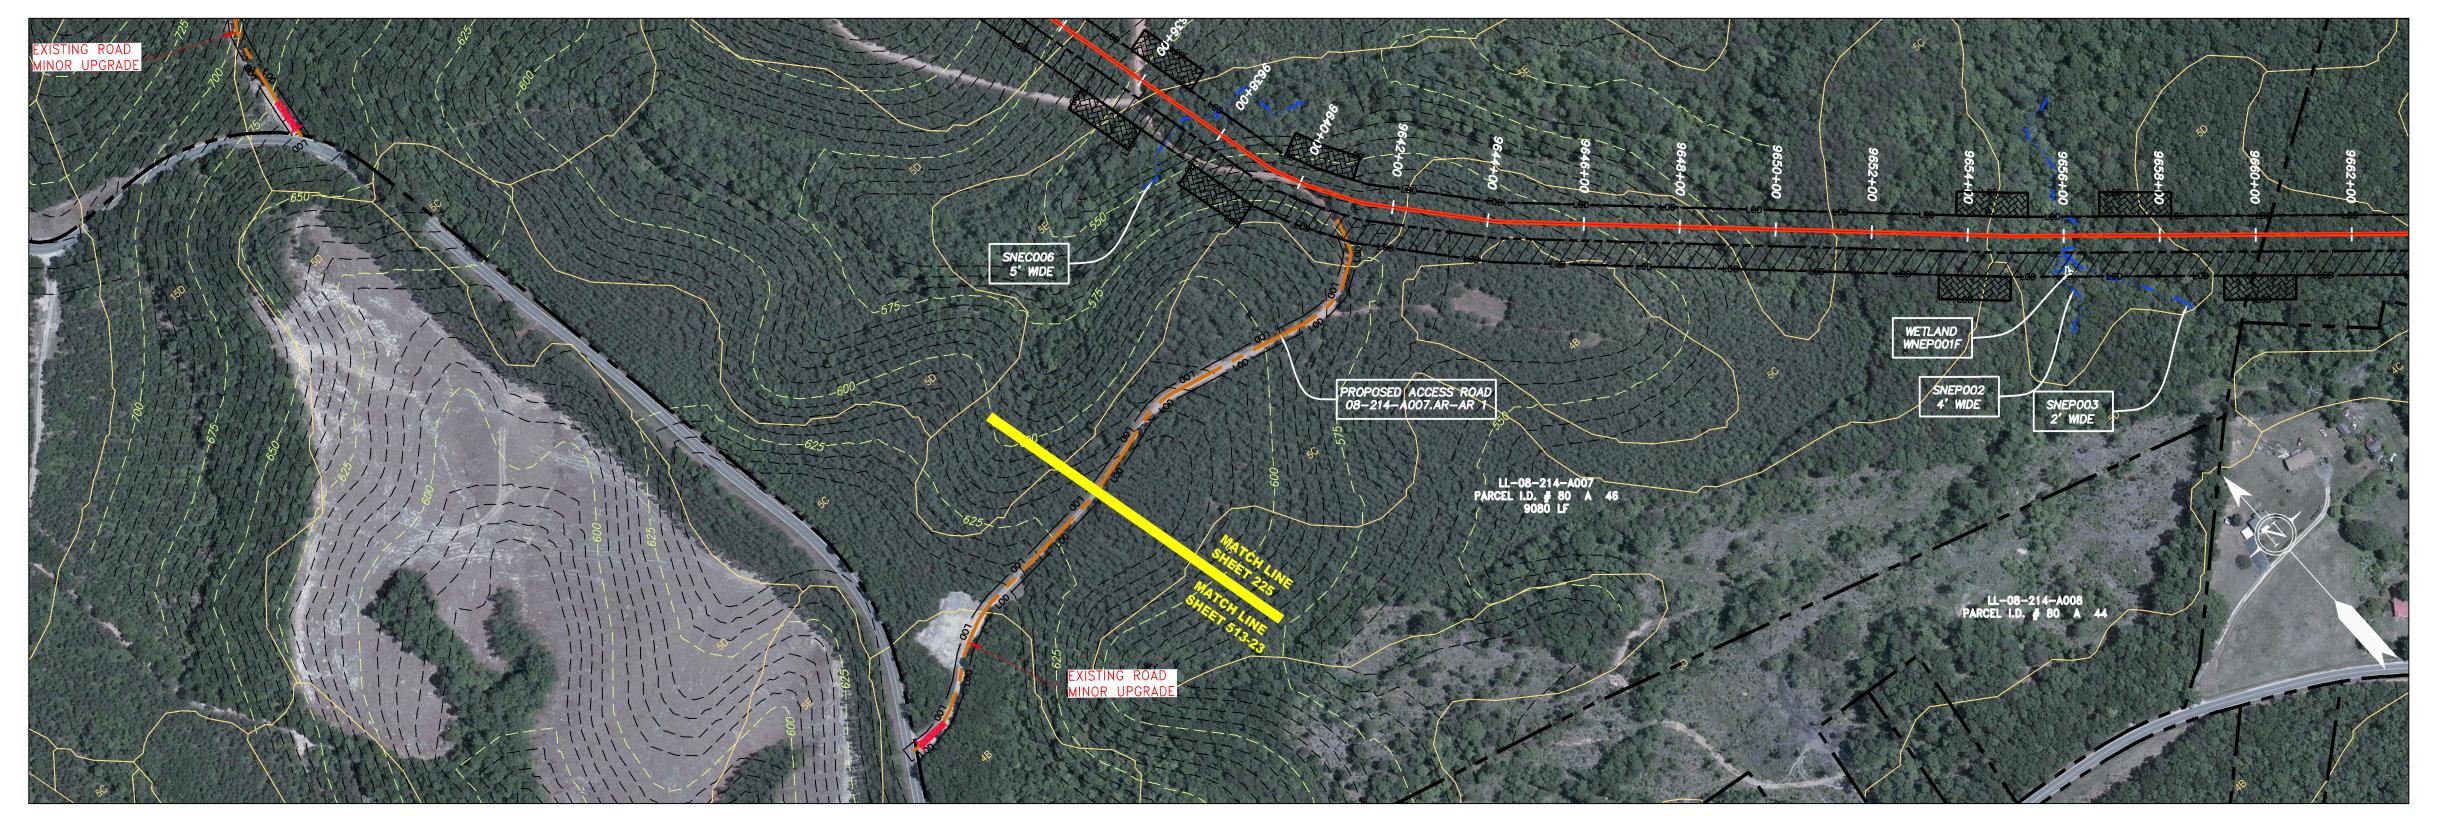

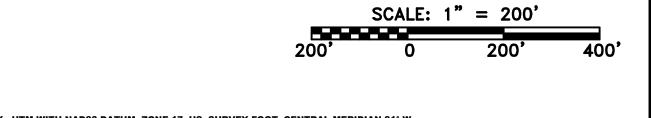

DANIEL R. GOLDSTEIN

ERM

SCALE: AS SHOWN

gai consultants

PROJECT NO./DASH NO

140468

TASK NO. SUB TASK NO

GROUP ID DRAWING NO.

AR-513

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E513


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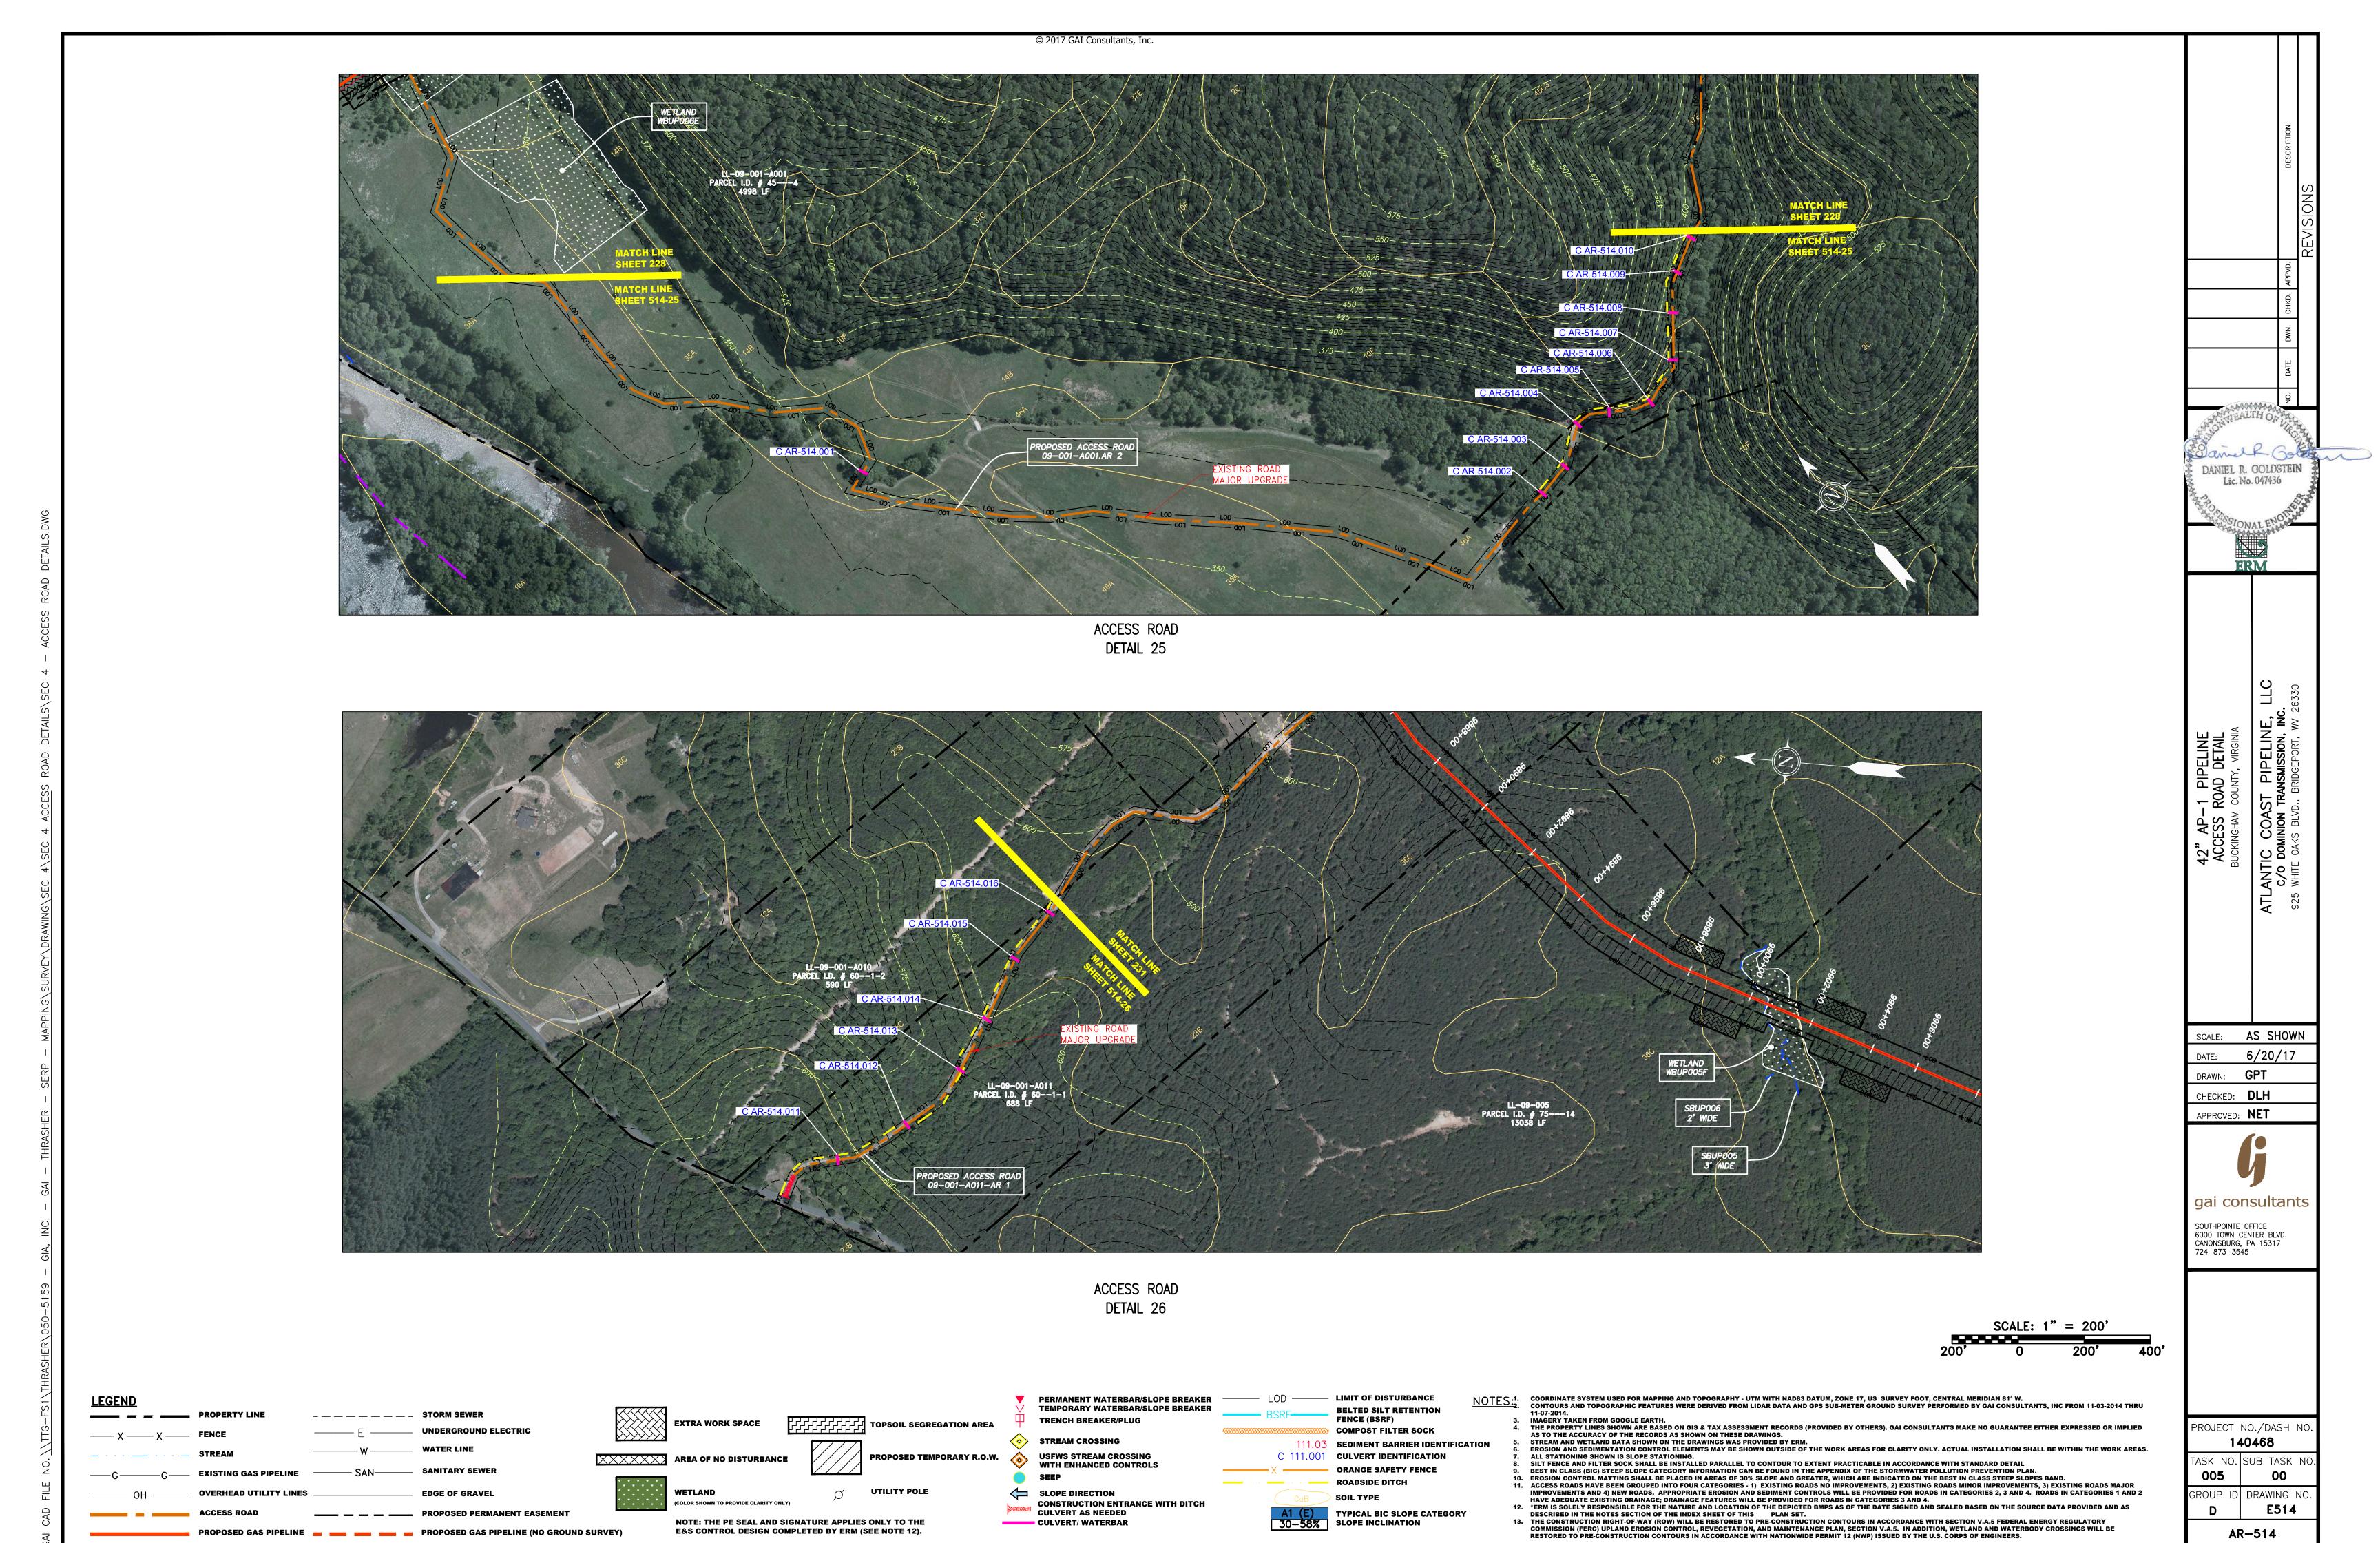
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APPROVED: **NET**


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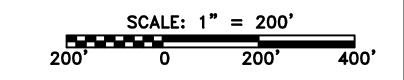
PERMANENT WATERBAR/SLOPE BREAKER ——— LOD ——— LIMIT OF DISTURBANCE





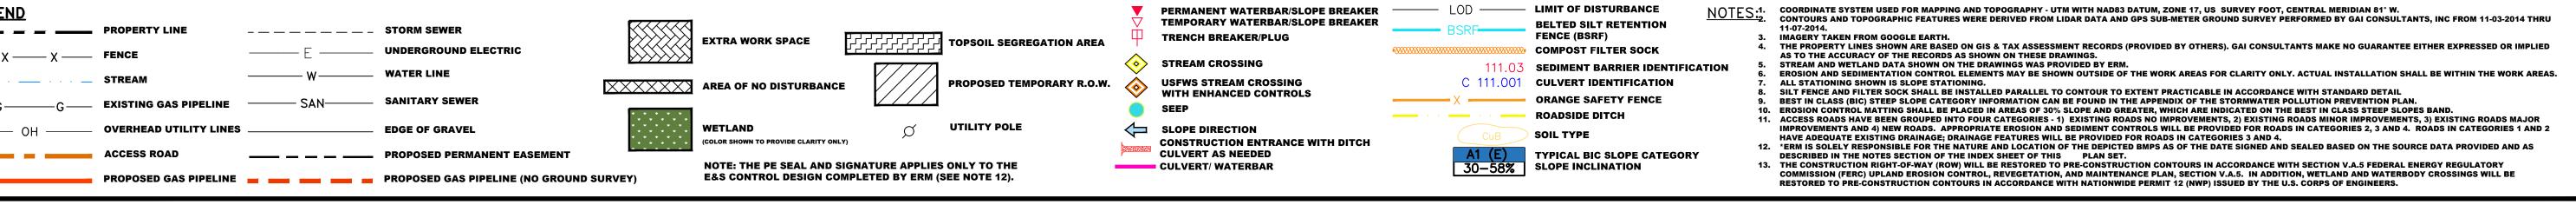

ACCESS ROAD DETAIL 28

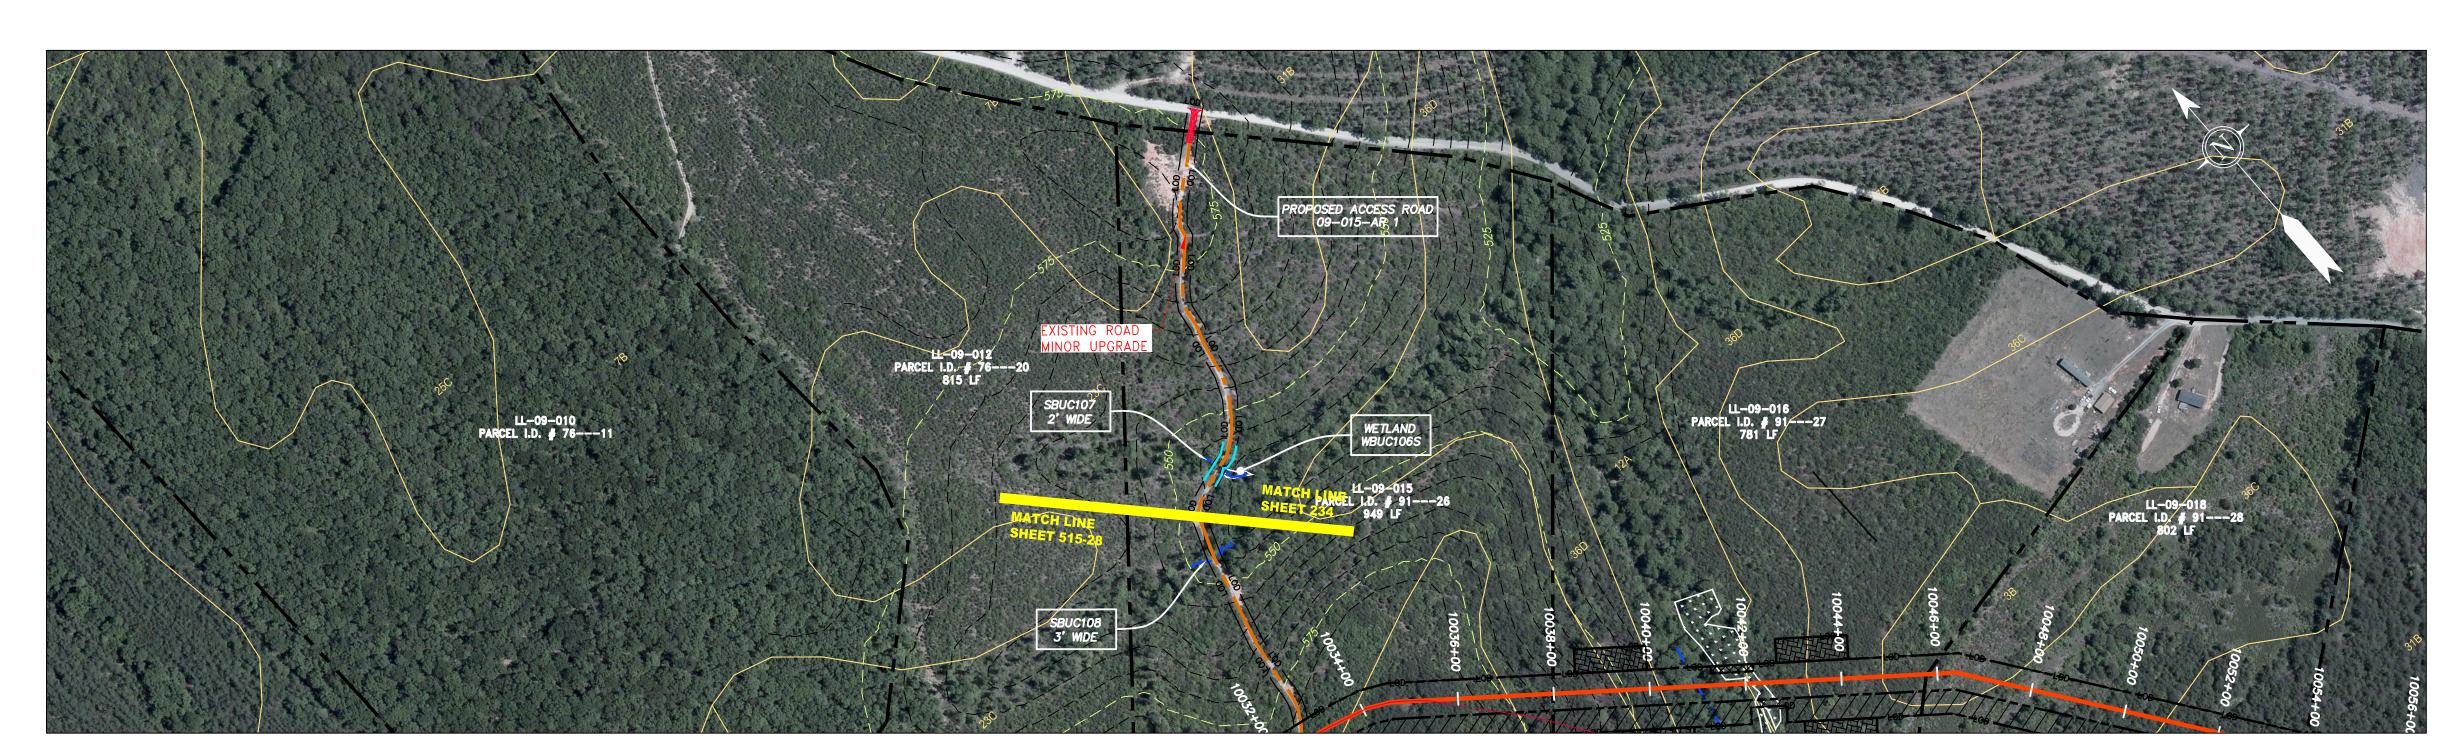

_ _ _ _ _ _ _ _ STORM SEWER **EXTRA WORK SPACE** TOPSOIL SEGREGATION AREA _____ F ____ UNDERGROUND ELECTRIC PROPOSED TEMPORARY R.O.W. AREA OF NO DISTURBANCE -G—— EXISTING GAS PIPELINE ———— SAN———— SANITARY SEWER UTILITY POLE ____ OVERHEAD UTILITY LINES ACCESS ROAD PROPOSED PERMANENT EASEMENT NOTE: THE PE SEAL AND SIGNATURE APPLIES ONLY TO THE E&S CONTROL DESIGN COMPLETED BY ERM (SEE NOTE 12). PROPOSED GAS PIPELINE PROPOSED GAS PIPELINE (NO GROUND SURVEY)

PERMANENT WATERBAR/SLOPE BREAKER ——— LOD ——— LIMIT OF DISTURBANCE TEMPORARY WATERBAR/SLOPE BREAKER TRENCH BREAKER/PLUG STREAM CROSSING **USFWS STREAM CROSSING** WITH ENHANCED CONTROLS SLOPE DIRECTION CONSTRUCTION ENTRANCE WITH DITCH CULVERT AS NEEDED CULVERT/ WATERBAR

30-58% SLOPE INCLINATION

BELTED SILT RETENTION FENCE (BSRF) COMPOST FILTER SOCK 111.03 SEDIMENT BARRIER IDENTIFICATION C 111.001 CULVERT IDENTIFICATION ORANGE SAFETY FENCE ROADSIDE DITCH SOIL TYPE TYPICAL BIC SLOPE CATEGORY

NOTES:1. COORDINATE SYSTEM USED FOR MAPPING AND TOPOGRAPHY - UTM WITH NAD83 DATUM, ZONE 17, US SURVEY FOOT, CENTRAL MERIDIAN 81° W. CONTOURS AND TOPOGRAPHIC FEATURES WERE DERIVED FROM LIDAR DATA AND GPS SUB-METER GROUND SURVEY PERFORMED BY GAI CONSULTANTS, INC FROM 11-03-2014 THRU 11-07-2014. 11-07-2014.

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6. EROSION AND SEDIMENTATION CONTROL ELEMENTS MAY BE SHOWN OUTSIDE OF THE WORK AREAS FOR CLARITY ONLY. ACTUAL INSTALLATION SHALL BE WITHIN THE WORK AREAS.

7. ALL STATIONING SHOWN IS SLOPE STATIONING.

8. SILT FENCE AND FILTER SOCK SHALL BE INSTALLED PARALLEL TO CONTOUR TO EXTENT PRACTICABLE IN ACCORDANCE WITH STANDARD DETAIL

9. BEST IN CLASS (BIC) STEEP SLOPE CATEGORY INFORMATION CAN BE FOUND IN THE APPENDIX OF THE STORMWATER POLLUTION PREVENTION PLAN.

10. EROSION CONTROL MATTING SHALL BE PLACED IN AREAS OF 30% SLOPE AND GREATER, WHICH ARE INDICATED ON THE BEST IN CLASS STEEP SLOPES BAND.

11. ACCESS ROADS HAVE BEEN GROUPED INTO FOUR CATEGORIES - 1) EXISTING ROADS NO IMPROVEMENTS, 2) EXISTING ROADS MINOR IMPROVEMENTS, 3) EXISTING ROADS MAJOR IMPROVEMENTS AND 4) NEW ROADS. APPROPRIATE EROSION AND SEDIMENT CONTROLS WILL BE PROVIDED FOR ROADS IN CATEGORIES 2, 3 AND 4. ROADS IN CATEGORIES 1 AND 2 HAVE ADEQUATE EXISTING DRAINAGE; DRAINAGE; BEATURES WILL BE PROVIDED FOR ROADS IN CATEGORIES 3 AND 4.

12. *ERM IS SOLELY RESPONSIBLE FOR THE NATURE AND LOCATION OF THE DEPICTED BMPS AS OF THE DATE SIGNED AND SEALED BASED ON THE SOURCE DATA PROVIDED AND AS DESCRIBED IN THE NOTES SECTION OF THE INDEX SHEET OF THIS PLAN SET.

DESCRIBED IN THE NOTES SECTION OF THE INDEX SHEET OF THIS PLAN SET.

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ERM

SCALE: AS SHOWN 6/20/17 DRAWN: **GPT** CHECKED: **DLH** APPROVED: **NET**


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PROJECT NO./DASH NO 140468 00

TASK NO. SUB TASK NO GROUP ID DRAWING NO. E515

AR-515



_ _ _ _ _ _ _ _ STORM SEWER EXTRA WORK SPACE TOPSOIL SEGREGATION AREA _____ [____ UNDERGROUND ELECTRIC _____ W ____ WATER LINE AREA OF NO DISTURBANCE _G____ EXISTING GAS PIPELINE _____ SAN____ SANITARY SEWER UTILITY POLE ____ OVERHEAD UTILITY LINES ____ (COLOR SHOWN TO PROVIDE CLARITY ONLY) ACCESS ROAD ____ PROPOSED PERMANENT EASEMENT NOTE: THE PE SEAL AND SIGNATURE APPLIES ONLY TO THE

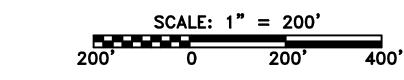PROPOSED GAS PIPELINE PROPOSED GAS PIPELINE (NO GROUND SURVEY)

PROPOSED TEMPORARY R.O.W.

E&S CONTROL DESIGN COMPLETED BY ERM (SEE NOTE 12).

PERMANENT WATERBAR/SLOPE BREAKER ——— LOD ——— LIMIT OF DISTURBANCE TEMPORARY WATERBAR/SLOPE BREAKER TRENCH BREAKER/PLUG STREAM CROSSING **USFWS STREAM CROSSING** WITH ENHANCED CONTROLS SLOPE DIRECTION CONSTRUCTION ENTRANCE WITH DITCH CULVERT AS NEEDED CULVERT/ WATERBAR

A1 (E) TYPICAL BIC SLOPE CATEGORY 30-58% SLOPE INCLINATION

BELTED SILT RETENTION FENCE (BSRF) COMPOST FILTER SOCK 111.03 SEDIMENT BARRIER IDENTIFICATION C 111.001 CULVERT IDENTIFICATION ORANGE SAFETY FENCE ROADSIDE DITCH SOIL TYPE

NOTES:1. COORDINATE SYSTEM USED FOR MAPPING AND TOPOGRAPHY - UTM WITH NAD83 DATUM, ZONE 17, US SURVEY FOOT, CENTRAL MERIDIAN 81° W.
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11-07-2014.

CONTOURS AND TOPOGRAPHIC FEATURES WERE DERIVED FROM LIDAR DATA AND GF3 300-METER GROUND SORVET FEM ORDINED STORY TO THE CONSTRUCTION OF THE RECORD AS TO THE PROPERTY LINES SHOWN ARE BASED ON GIS & TAX ASSESSMENT RECORDS (PROVIDED BY OTHERS). GAI CONSULTANTS MAKE NO GUARANTEE EITHER EXPRESSED OR IMPLIED AS TO THE ACCURACY OF THE RECORDS AS SHOWN ON THESE DRAWINGS.

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SCALE: AS SHOWN 6/20/17 DRAWN: **GPT** CHECKED: **DLH** APPROVED: **NET**

ERM

gai consultants

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PROJECT NO./DASH NO. 140468 00

TASK NO. SUB TASK NO GROUP ID DRAWING NO. E516 AR-516